

CONSTRUCTION TYPICAL DORM REFLECTED CEILING PLAN

CONSTRUCTION OFFICE SECTION REFLECTED CEILING PLAN	
SCALE: $1/4" = 1'-0"$	4-102

SYM	REVISIONS	DATE	APPROVED										
B	AMENDMENT 0010	08.04.22											
GE	GENERAL NOTES												

- 1. CONTRACTOR TO FIELD VERIFY ALL EXISTING DIMENSIONS BEFORE COMMENCING WORK.
- 2. SEE CIVIL, STRUCTURAL, PLUMBING, MECHANICAL, AND ELECTRICAL DRAWINGS FOR ADDITIONAL NOTES.
- 3. PAINT INTERIOR CMU WALLS AND CONCRETE CEILINGS WHERE EXPOSED. SEE SPECIFICATION, DIVISION 099000 PAINTS AND COATINGS, 3.2 SURFACE PREPARATIONS.
- 4. PROTECT EXISTING ITEMS TO REMAIN.

CON	ISTRUCTION NOTES
MARK	DESCRIPTION
1	PAINT CONCRETE CEILING.
2	PROVIDE ACOUSTICAL CEILING GRID, TILE, AND HANGERS. SEE FINISH SCHEDULE.
3	PROVIDE METAL STUD FRAMING AND 5/8" GYPSUM BOARD CEILING, FINISH AND PAINT.
4	PROVIDE HVAC DIFFUSER, SEE MECHANICAL.
5	PROVIDE LIGHTING, SEE ELECTRICAL.
6	PROVIDE 3-5/8" METAL STUD BULKHEAD WITH 5/8" GYPSUM BOARD, FINISH AND PAINT.
7	PROVIDE 24" X 24" METAL ACCESS HATCH FOR HVAC.

CONSTRU	CTION CEILING LEGEND
	PRECAST CONCRETE CEILING. PAINT.
	NEW 5/8" GYPSUM BOARD CEILING ATTACHED TO 3-5/8" METAL STUD FRAMING, FINISH AND PAINT.
	2x2 ACOUSTICAL CEILING TILES, GRID, AND HANGERS
0	NEW LIGHT FIXTURES, SEE ELECTRICAL.
	NEW HVAC DIFFUSER/EXHUAST. SEE MECHANICAL.
<del>0</del> '-0"	CEILING ELEVATION

# DISCLOSURE OF INFORMATION CONTRACTOR SHALL COMPLY AS FOLLOWS:

- (A) THE CONTRACTOR SHALL NOT RELEASE TO ANYONE OUTSIDE THE CONTRACTOR'S ORGANIZATION ANY UNCLASSIFIED INFORMATION, REGARDLESS OF MEDIUM (E.G., FILM, TAPE, DOCUMENT), PERTAINING TO ANY PART OF THIS CONTRACT OR ANY PROGRAM RELATED TO
  - THIS CONTRACT, UNLESS-
- (1) THE CONTRACTING OFFICER HAS GIVEN PRIOR WRITTEN APPROVAL; OR (2) THE INFORMATION IS OTHERWISE IN THE PUBLIC DOMAIN BEFORE THE DATE OF RELEASE
- (B) REQUESTS FOR APPROVAL SHALL IDENTIFY THE SPECIFIC INFORMATION TO BE RELEASED, THE MEDIUM TO BE USED, AND THE PURPOSE FOR THE RELEASE. THE CONTRACTOR SHALL SUBMIT ITS REQUEST TO THE CONTRACTING OFFICER AT LEAST 45 DAYS BEFORE THE
- PROPOSED DATE FOR RELEASE. (C) THE CONTRACTOR AGREES TO INCLUDE A SIMILAR REQUIREMENT IN EACH SUBCONTRACT UNDER HIS CONTRACT. SUBCONTRACTORS SHALL SUBMIT REQUESTS FOR AUTHORIZATION TO RELEASE THROUGH THE PRIME CONTRACTOR TO THE CONTRACTING OFFICER.




DES. C.WALKER DR. T.AMOS CHK. J.WALKER SUBMITTED BY: B.WALKER


MARINE CORPS BASE CAMP LEJEUNE, NORTH CAROLINA

REPAIR BEQ FC530

DESIGN DIR. T.H. BURTON P.E. CONSTRUCTION ENLARGED REFLECTED CEILING PLANS DATE SIZE CODE IDENT. NO navfac drawing no. 60035766


CONST. CONTR. NO. N40085-20-B-0075 SATISFACTORY TO: SCALE: NOTED | SPEC. 20-0075 SHEET XX OF 141

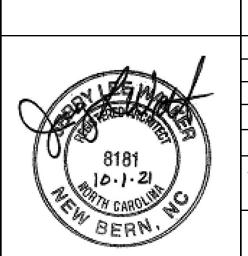

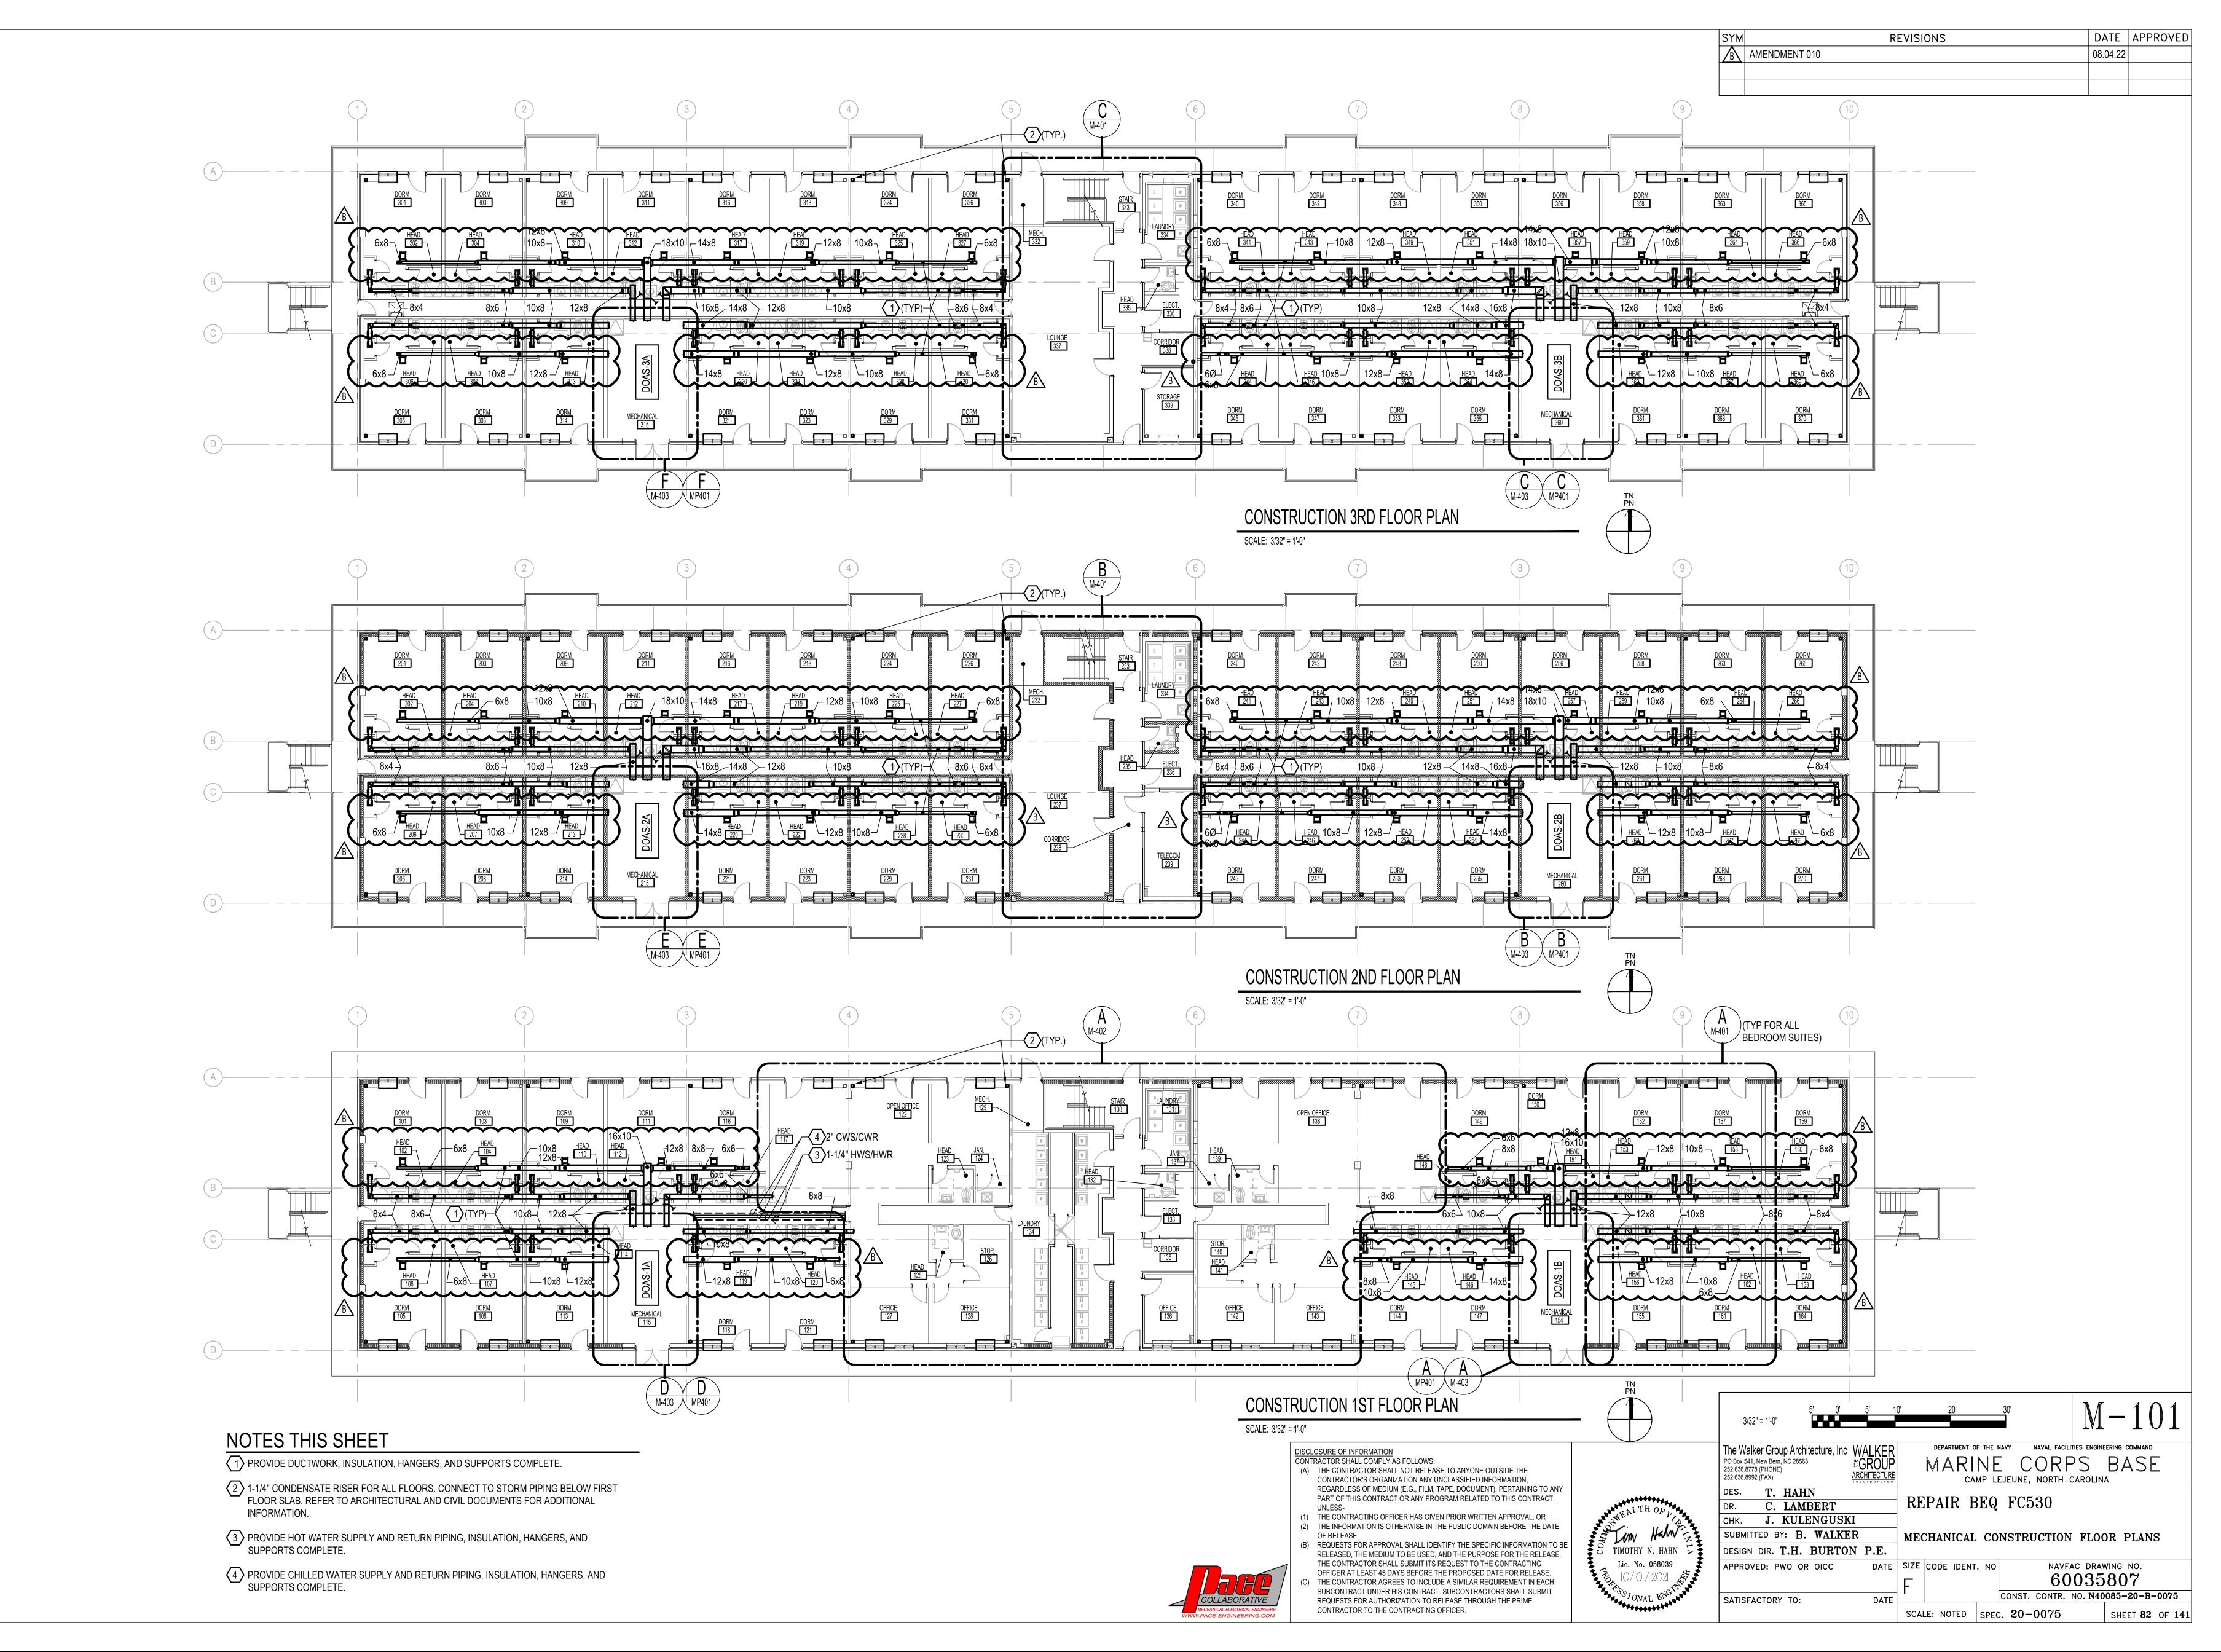

1055\DWGS\21055\_M-101.dwq PLOT DATE/TIME: 8/4/2022 - 4:58pr

DATE APPROVED REVISIONS AMENDMENT 010

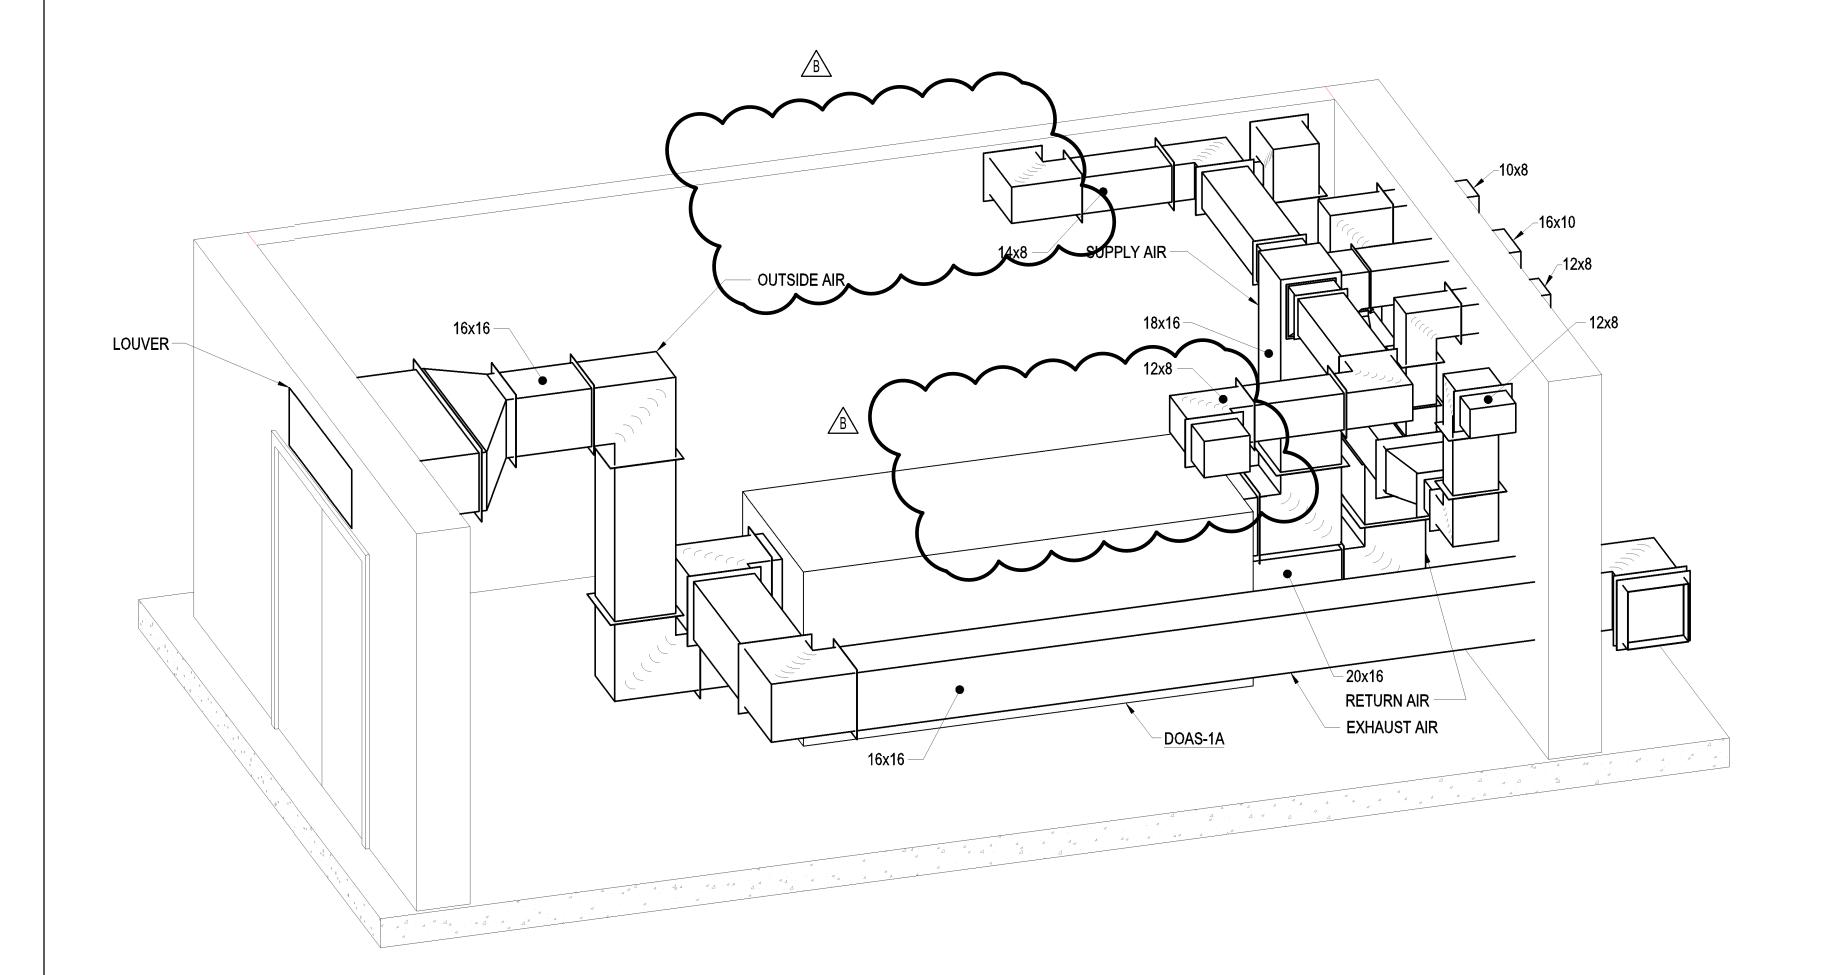

OUTSIDE AIR SUPPLY AIR EXHAUST AIR RETURN AIR DOAS-1A 

TYPICAL MECHANICAL ROOM SECTION

OUTSIDE AIR 20x16-RETURN AIR -

TYPICAL MECHANICAL ROOM PERSPECTIVE VIEW "B" SCALE: NO SCALE


TYPICAL MECHANICAL ROOM PERSPECTIVE VIEW "A"

DISCLOSURE OF INFORMATION
CONTRACTOR SHALL COMPLY AS FOLLOWS:

(A) THE CONTRACTOR SHALL NOT RELEASE TO ANYONE OUTSIDE THE CONTRACTOR'S ORGANIZATION ANY UNCLASSIFIED INFORMATION, REGARDLESS OF MEDIUM (E.G., FILM, TAPE, DOCUMENT), PERTAINING TO ANY PART OF THIS CONTRACT OR ANY PROGRAM RELATED TO THIS CONTRACT, (1) THE CONTRACTING OFFICER HAS GIVEN PRIOR WRITTEN APPROVAL; OR

CONTRACTOR TO THE CONTRACTING OFFICER.

(2) THE INFORMATION IS OTHERWISE IN THE PUBLIC DOMAIN BEFORE THE DATE OF RELEASE (B) REQUESTS FOR APPROVAL SHALL IDENTIFY THE SPECIFIC INFORMATION TO BE RELEASED, THE MEDIUM TO BE USED, AND THE PURPOSE FOR THE RELEASE. THE CONTRACTOR SHALL SUBMIT ITS REQUEST TO THE CONTRACTING OFFICER AT LEAST 45 DAYS BEFORE THE PROPOSED DATE FOR RELEASE. THE CONTRACTOR AGREES TO INCLUDE A SIMILAR REQUIREMENT IN EACH SUBCONTRACT UNDER HIS CONTRACT. SUBCONTRACTORS SHALL SUBMIT REQUESTS FOR AUTHORIZATION TO RELEASE THROUGH THE PRIME

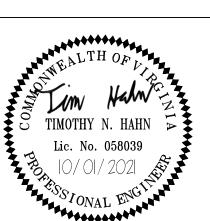

The Walker Group Architecture, Inc WALKER	DEPARTMENT OF THE NAVY NAVAL FACILITIES ENGINEERING COMMAND
PO Box 541, New Bern, NC 28563 252.636.8778 (PHONE)	MARINE CORPS BASE
252.636.8992 (FAX)  ARCHITECTURE	CAMP LEJEUNE, NORTH CAROLINA
DES. T. HAHN	DEDAID DES HOESS
DR. C. LAMBERT	REPAIR BEQ FC530
снк. <b>J. KULENGUSKI</b>	
SUBMITTED BY: B. WALKER	MECHANICAL ROOM ISOMETRIC VIEWS AND
DESIGN DIR. T.H. BURTON P.E.	SECTION

DATE \_\_


APPROVED: PWO OR OICC

SATISFACTORY TO:


SCALE: NOTED SPEC. 20-0075


DATE SIZE CODE IDENT. NO NAVFAC DRAWING NO. 60035809 CONST. CONTR. NO. N40085-20-B-0075


SHEET **84** OF **141** 

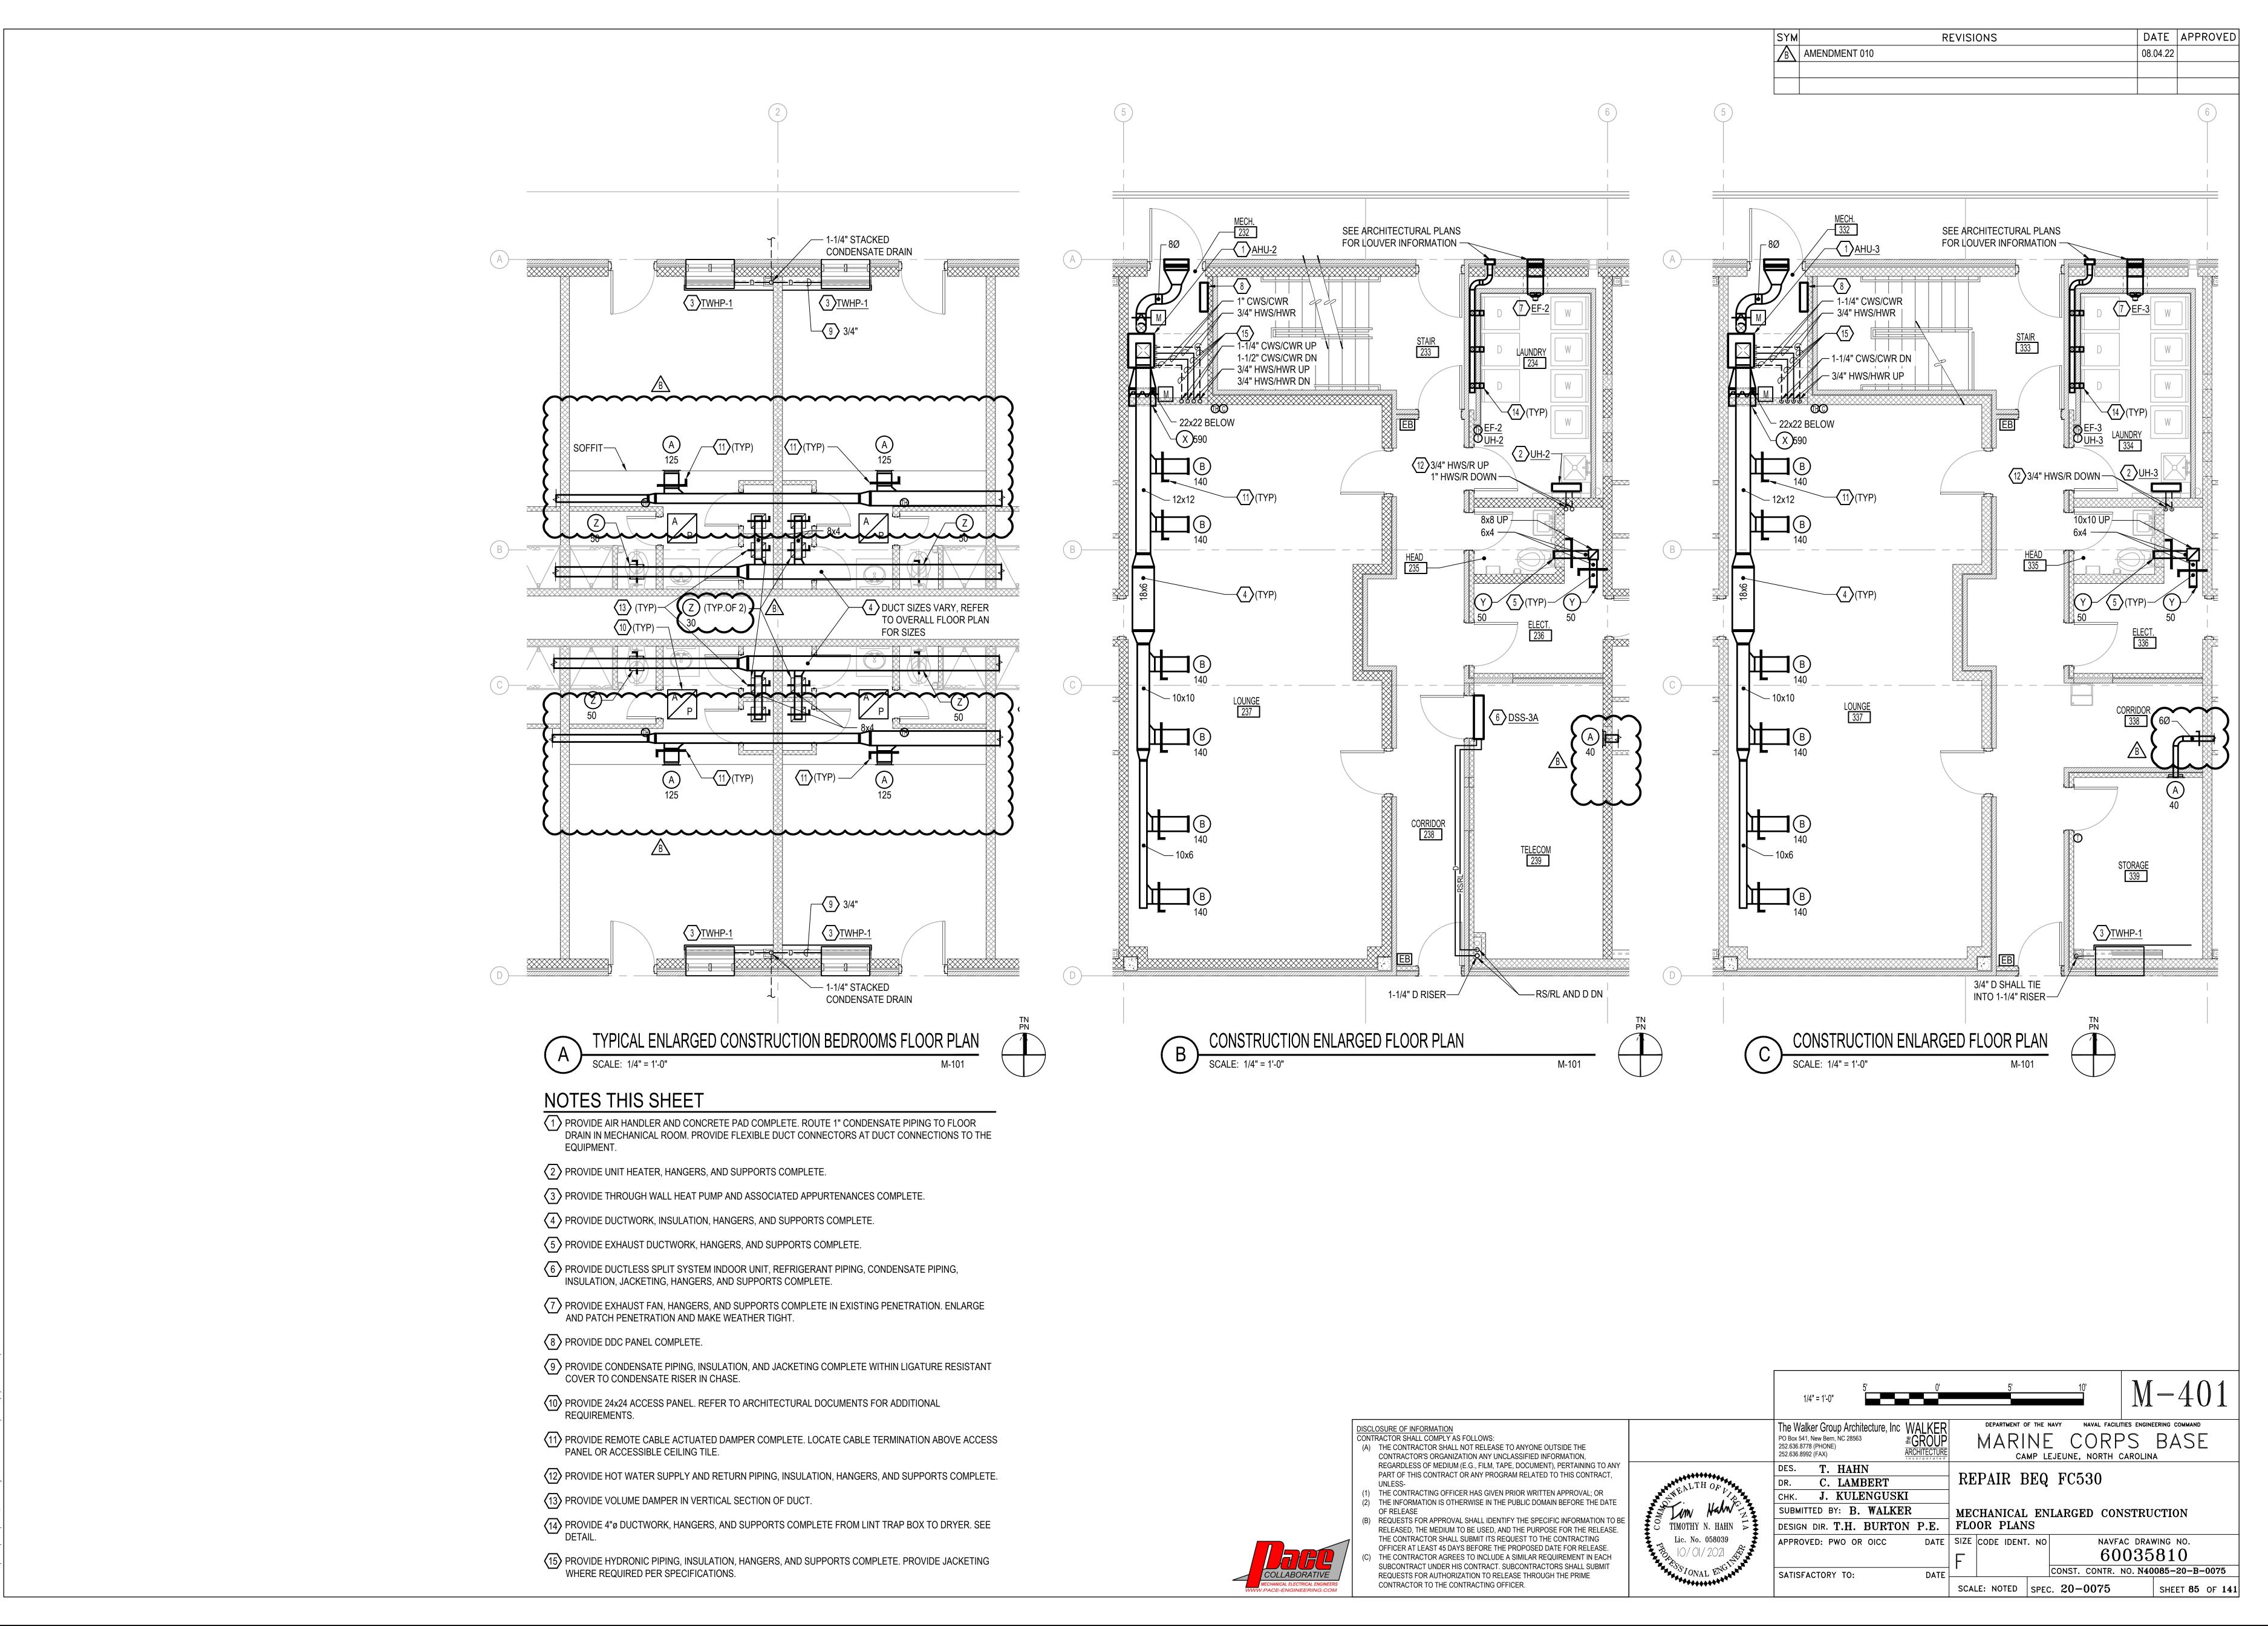


ILE: X:\21055\DWGS\21055\_M-401.dwq PLOT DATE/TIME: 8/4/2022 - 5

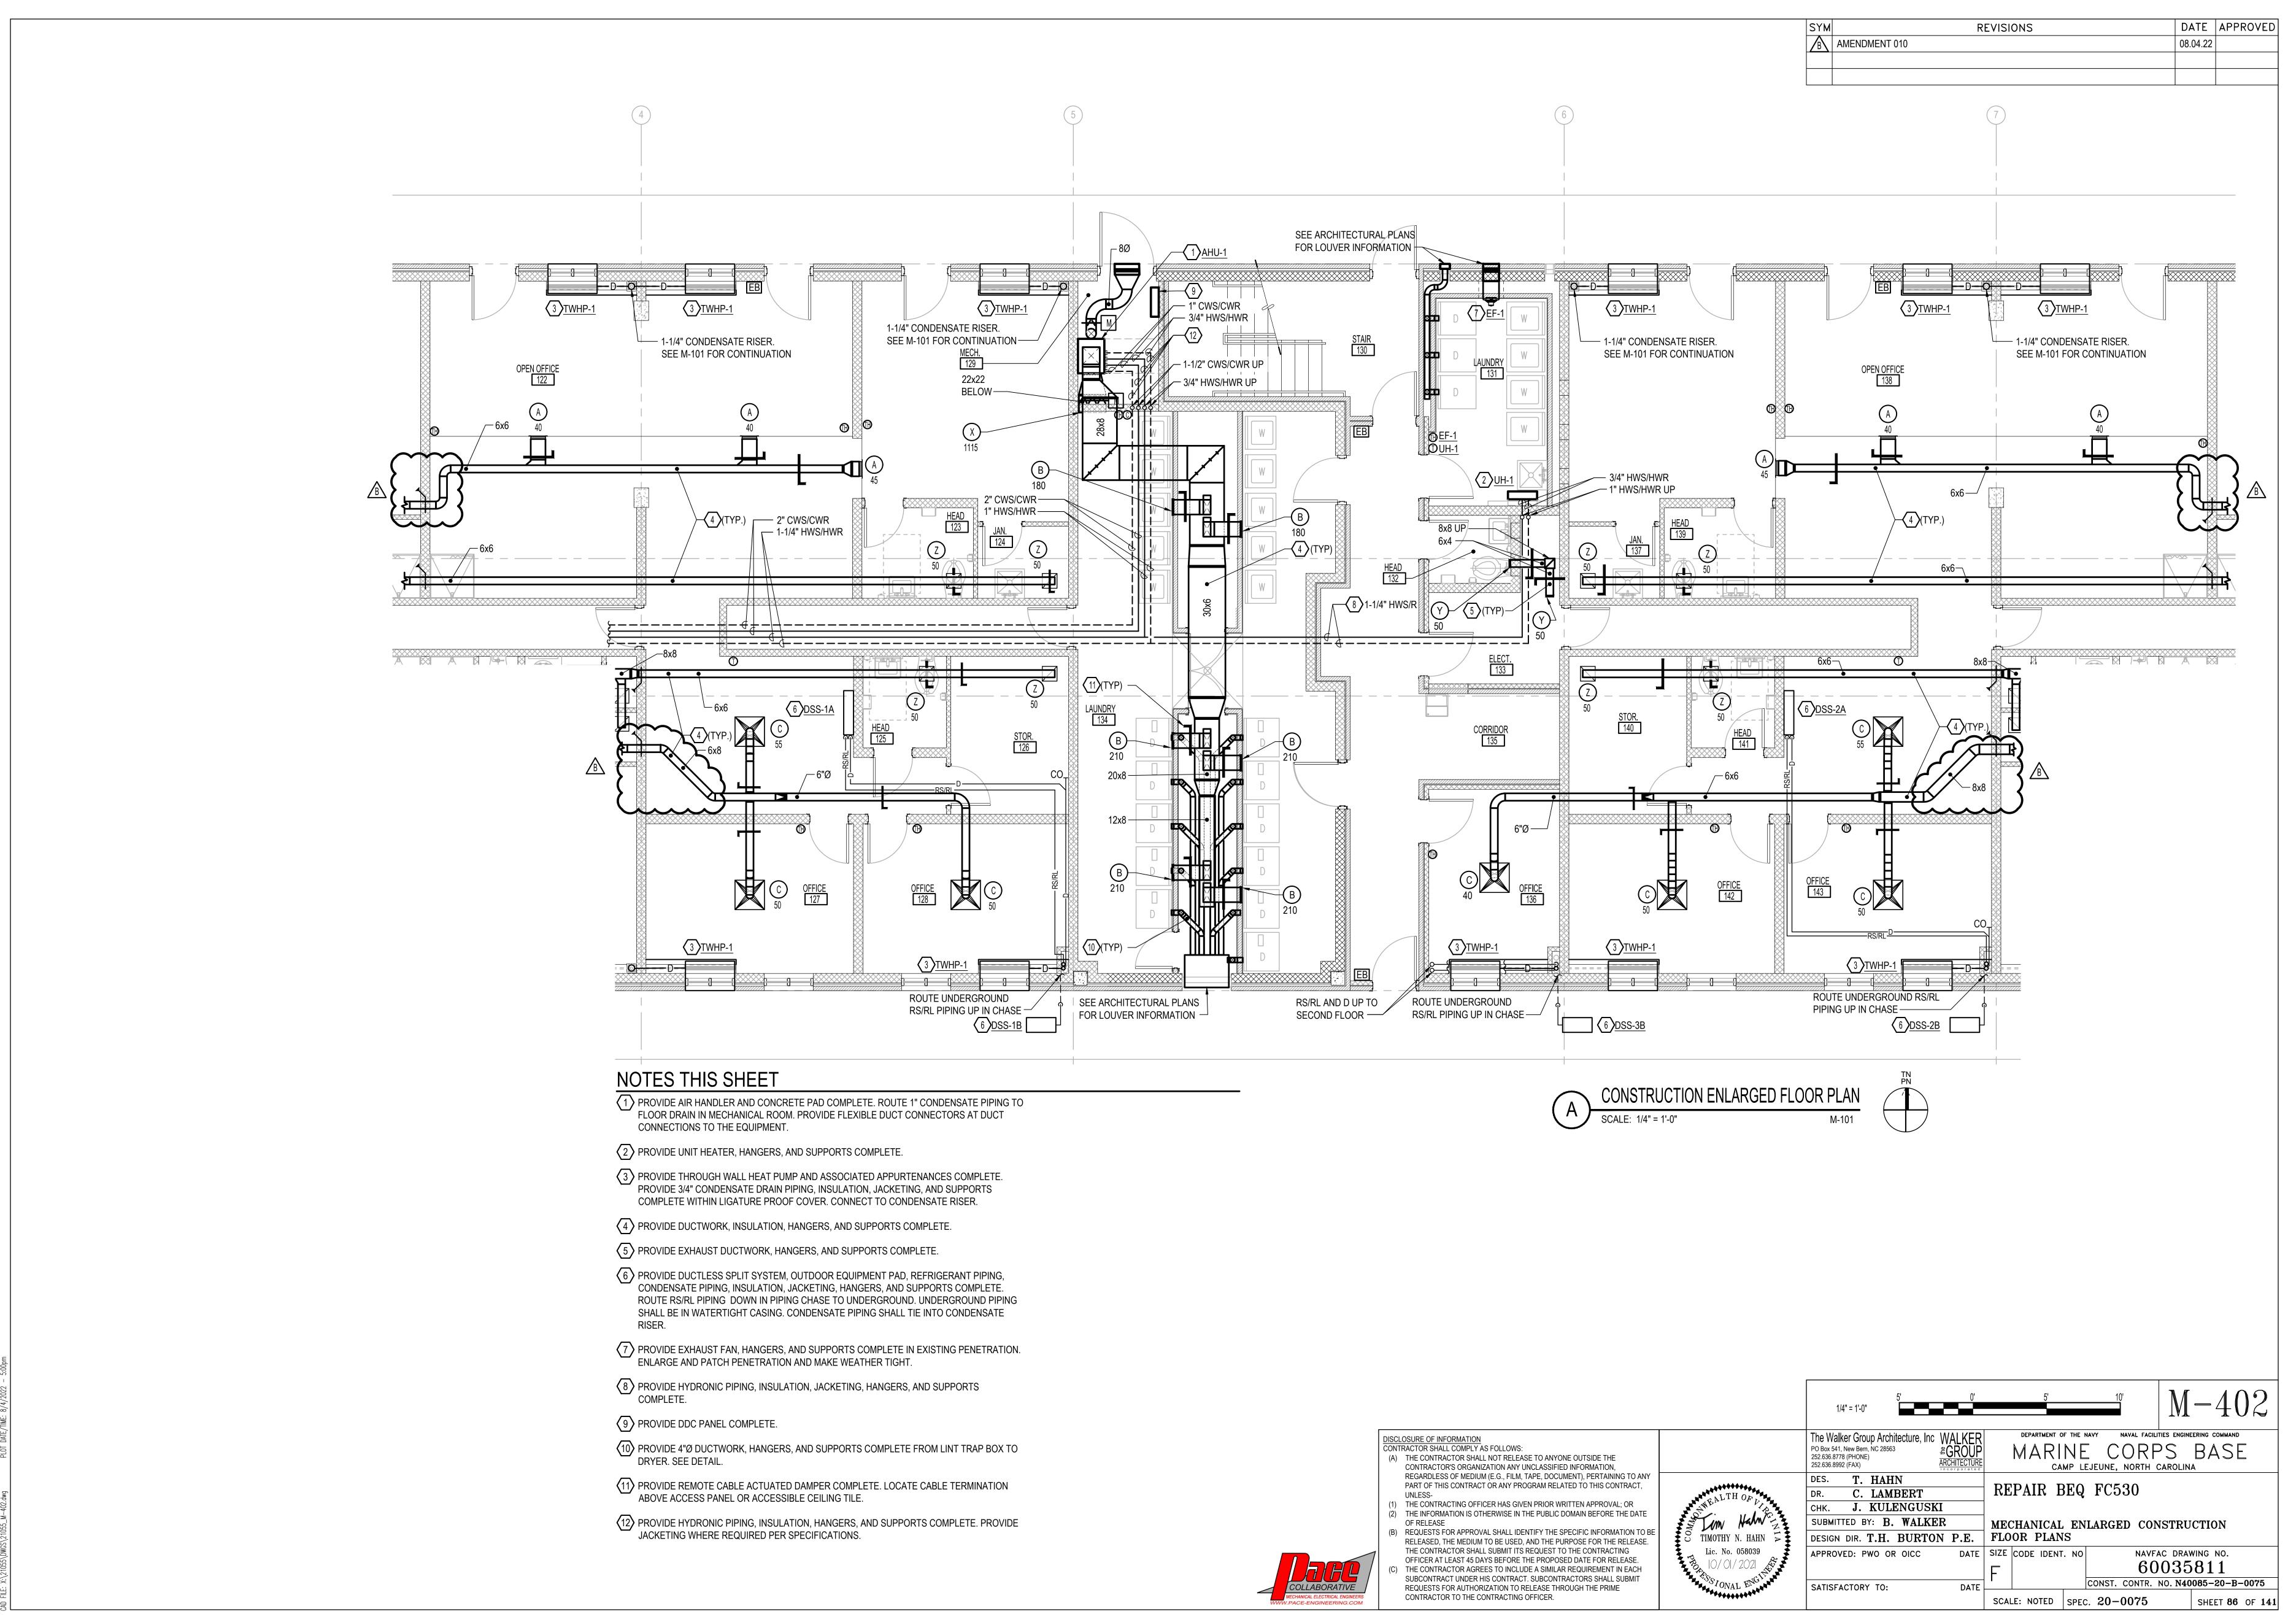

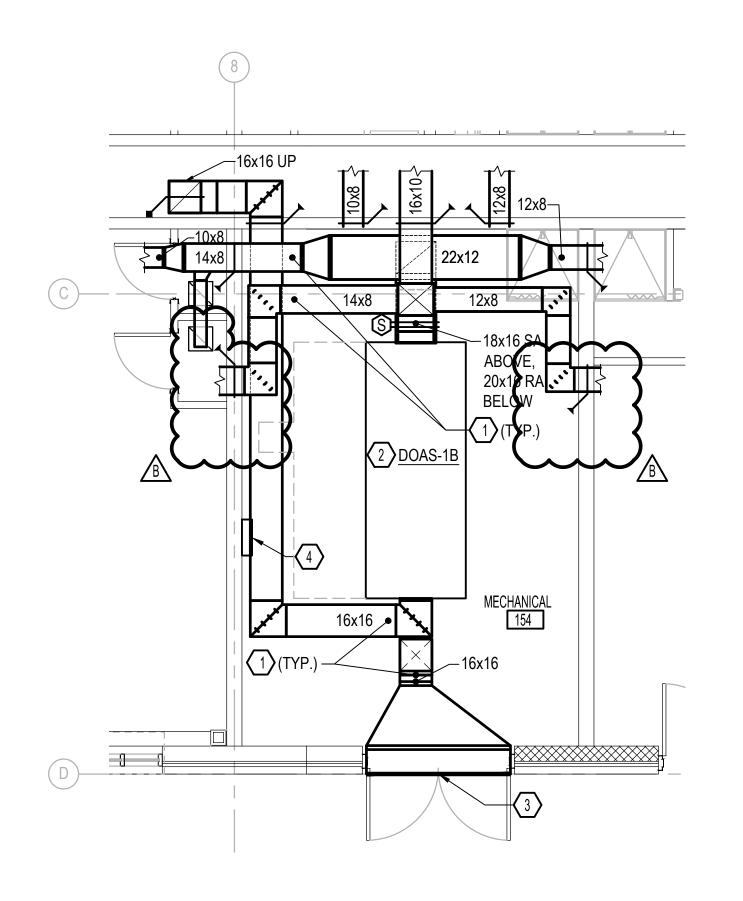


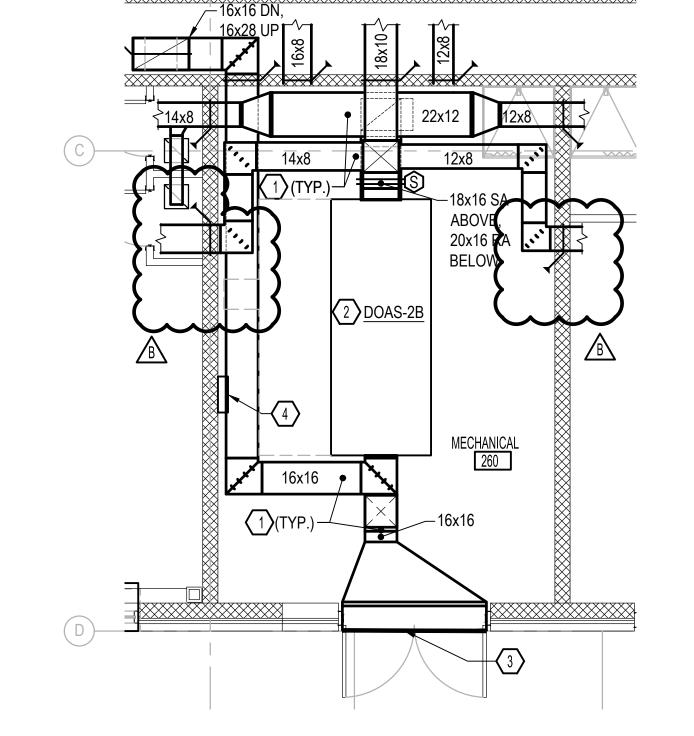


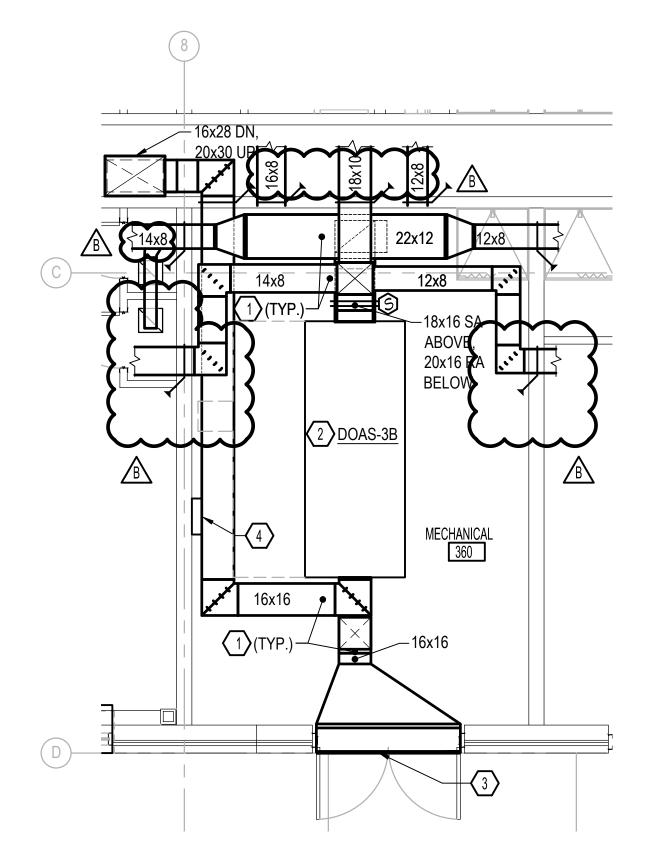







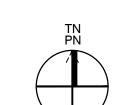

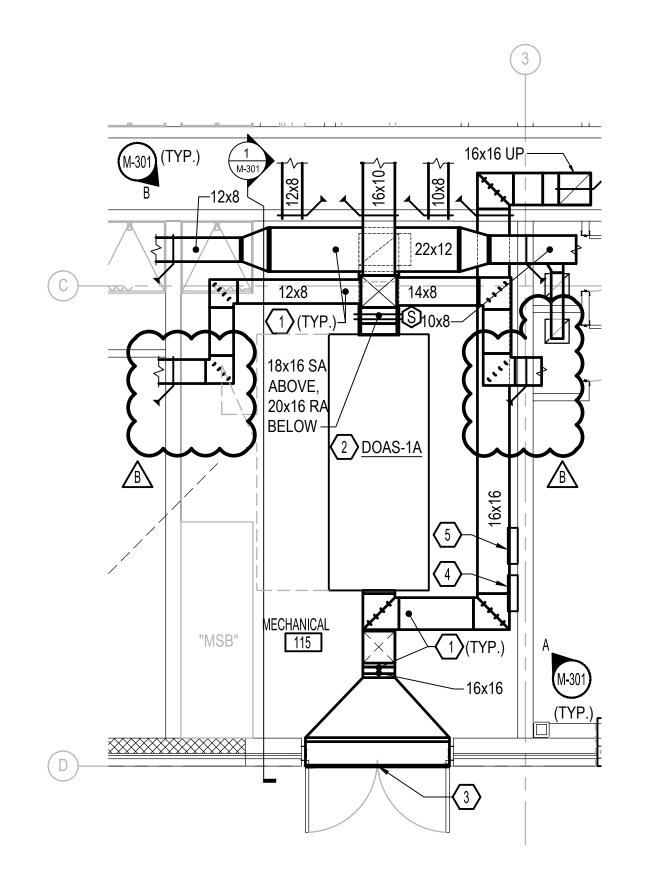

MECHANICAL ENLARGED CONSTRUCTION FIRST FLOOR PLAN

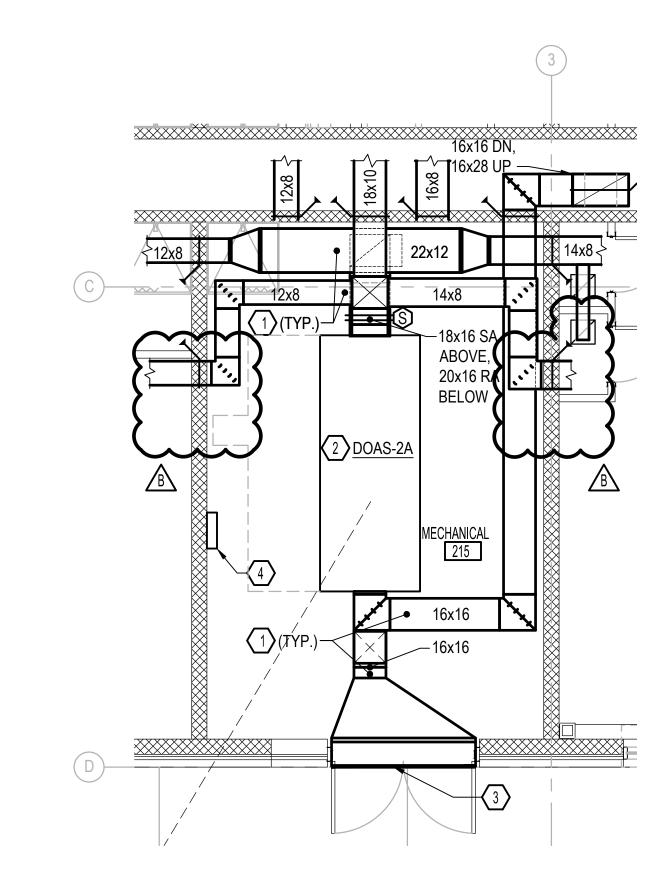

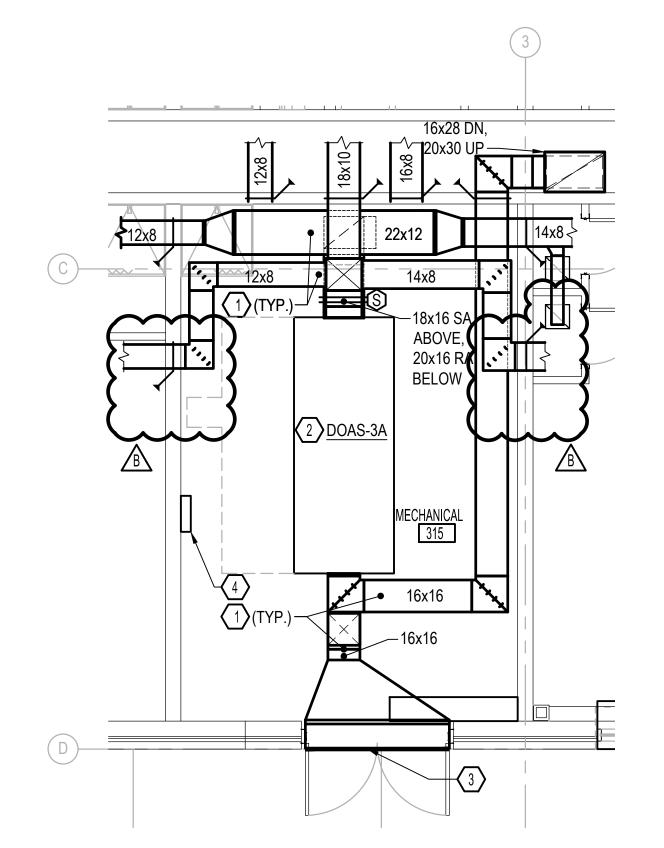




MECHANICAL ENLARGED CONSTRUCTION SECOND FLOOR PLAN

MECHANICAL ENLARGED CONSTRUCTION THIRD FLOOR PLAN



- 1 PROVIDE DUCTWORK, INSULATION, HANGERS, AND SUPPORTS COMPLETE.
- 2 PROVIDE DEDICATED OUTDOOR AIR UNIT, CONCRETE PAD, AND ASSOCIATED APPURTENANCES COMPLETE. PROVIDE FLEXIBLE DUCT CONNECTORS AT DUCT CONNECTIONS TO THE EQUIPMENT.
- LOUVER. REFER TO ARCHITECTURAL PLANS FOR LOUVER SIZE AND REQUIREMENTS. PROVIDE DUCTWORK TRANSITION TO FULL SIZE OF LOUVER COMPLETE.
- 4 PROVIDE DDC PANEL COMPLETE.
- 5 PROVIDE BUILDING SUPERVISORY BUILDING CONTROLLER COMPLETE.



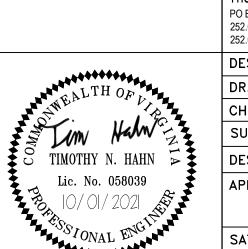

SUBMITTED BY: B. WALKER

MARINE CORPS BASE PO Box 541, New Bern, NC 28563 252.636.8778 (PHONE) ARCHITECTURE CAMP LEJEUNE, NORTH CAROLINA DES. T. HAHN REPAIR BEQ FC530 DR. C. LAMBERT снк. **J. KULENGUSKI** 

MECHANICAL ENLARGED CONSTRUCTION

NAVFAC DRAWING NO. 60035812

DATE \_ SCALE: NOTED SPEC. 20-0075

CONTRACTOR TO THE CONTRACTING OFFICER.

DISCLOSURE OF INFORMATION CONTRACTOR SHALL COMPLY AS FOLLOWS:

OF RELEASE

(A) THE CONTRACTOR SHALL NOT RELEASE TO ANYONE OUTSIDE THE

CONTRACTOR'S ORGANIZATION ANY UNCLASSIFIED INFORMATION,

REGARDLESS OF MEDIUM (E.G., FILM, TAPE, DOCUMENT), PERTAINING TO ANY

PART OF THIS CONTRACT OR ANY PROGRAM RELATED TO THIS CONTRACT,

(1) THE CONTRACTING OFFICER HAS GIVEN PRIOR WRITTEN APPROVAL; OR (2) THE INFORMATION IS OTHERWISE IN THE PUBLIC DOMAIN BEFORE THE DATE (B) REQUESTS FOR APPROVAL SHALL IDENTIFY THE SPECIFIC INFORMATION TO BE RELEASED, THE MEDIUM TO BE USED, AND THE PURPOSE FOR THE RELEASE. THE CONTRACTOR SHALL SUBMIT ITS REQUEST TO THE CONTRACTING OFFICER AT LEAST 45 DAYS BEFORE THE PROPOSED DATE FOR RELEASE. THE CONTRACTOR AGREES TO INCLUDE A SIMILAR REQUIREMENT IN EACH SUBCONTRACT UNDER HIS CONTRACT. SUBCONTRACTORS SHALL SUBMIT REQUESTS FOR AUTHORIZATION TO RELEASE THROUGH THE PRIME

DESIGN DIR. T.H. BURTON P.E. FLOOR PLANS APPROVED: PWO OR OICC SATISFACTORY TO:

DATE SIZE CODE IDENT. NO CONST. CONTR. NO. N40085-20-B-0075 SHEET 87 OF 141

SYM	REVISIONS	DATE	APPROVED
® (	AMENDMENT 010	08.04.22	

			SUPPLY FA	N DATA				EXHAUS <sup>*</sup>	T FAN DA	TA	WINTER FIXED PLATE CHILLED WATER COOLING COIL DATA							SUMMER FIXED PLATE HOT WA				WATER H	WATER HEATING COIL DATA													
Γ					ELECTRIC	AL DATA	EXHAUST			ELECTRICAL DATA			TOTAL	SENS.								MAX.	MAX.					TOTAL						MAX.	MAX.	]
	OUTSIDE AIR	E.S.P.		FAN			AIR	E.S.P.			E.A.T	L.A.T.	CAPACITY	CAPACITY	E.D.B.	E.W.E	B. L.D.B.	L.W.B.	E.W.T.	L.W.T.		A.P.D.	W.P.D.	E.A.T DB	E.A.T WB	L.A.T DB	L.A.T. WB	CAPACITY	E.D.B.	L.D.B.	E.W.T.		L.W.T.	A.P.D.	W.P.D.	
TAG	(C.F.M.)	(IN. WG.)	H.P.	TYPE	VOLTS	PHASE	(C.F.M.)	(IN. WG.)	H.P.	VOLTS PHASE	(°F)	(°F)	M.B.H.	M.B.H.	(°F)	(°F)	(°F)	(°F)	(°F)	(°F)	G.P.M.	(IN. WG.)	(FT. WG.)	(°F)	(°F)	(°F)	(°F)	M.B.H.	(°F)	(°F)	(°F)	G.P.M.	(°F)	(IN. WG.)	(FT. WG.)	REI
OOAS-1A	1530	1.00	3	DIRECT	208	3	1300	1.50	3	208 3	26	68.0	101.4	54.4	83.1	71.8	51	50.9	44	54	20.5	0.59	12.10	91	77	81.0	71.0	60.5	48.6	85.0	140	3.14	100	0.12	3.95	SEE
OAS-1B	1570	1.00	3	DIRECT	208	3	1300	1.50	3	208 3	26	49.9	104.5	55.1	83.1	71.8	51	50.9	44	54	21.0	0.5	12.70	91	77	82.8	71.4	64.2	48.6	85.0	140	3.14	100	0.12	3.95	SEE
OAS-2A	1875	1.00	3	DIRECT	208	3	1650	1.50	3	208 3	26	68.0	125.1	66.1	83.1	71.8	51	50.9	44	54	25.0	1.04	6.55	91	77	81.0	71.0	74.0	48.6	85.0	140	3.90	100	0.17	5.79	SEE
OAS-2B	1875	1.00	3	DIRECT	208	3	1650	1.50	3	208 3	26	68.0	125.1	66.1	83.1	71.8	51	50.9	44	54	25.0	1.04	6.55	91	77	81.0	71.0	74.0	48.6	85.0	140	3.90	100	0.17	5.79	SEE
OAS-3A	1875	1.00	3	DIRECT	208	3	1650	1.50	3	208 3	26	68.0	125.1	66.1	83.1	71.8	51	50.9	44	54	25.0	1.04	6.55	91	77	81.0	71.0	74.0	48.6	85.0	140	3.90	100	0.17	5.79	SEE
OAS-3B	1915	1.00	3	DIRECT	208	3	1650	1.50	3	208 3	26	43.4	127.2	67.1	83.1	71.8	51	50.9	44	54	25.5	1.04	6.79	91	77	82.6	71.5	87.2	43.4	85.0	140	3.90	100	0.20	5.81	SEE

- 1. LEAVING AIR TEMPERATURE IS TO BE PROVIDED AT THE UNIT DISCHARGE, TOTAL & SENSIBLE CAPACITIES ARE "NET" VALUES TO BE PROVIDED DOWNSTREAM OF THE SUPPLY AIR FAN.
- 2. PROVIDE WITH INVERTER DUTY RATED MOTOR(S) AND VARIABLE FREQUENCY DRIVE(S), BACNET MS/TP INTERFACE, AND 22 GAUGE GALVANIZED STEEL EXTERIOR CASING WITH 1" THICK CLOSED CELL FOAM INSULATION (NON VOC) FOR ENTIRE UNIT...
- 3. PROVIDE WITH THE FOLLOWING SECTIONS: FLAT FILTER, TOTAL ENTHALPY CORE, COOLING COIL, REHEAT COIL, SUPPLY FAN AND EXHAUST FAN.
- 4. FIXED PLATE TOTAL ENTHALPY CORE SHALL HAVE AN EXHAUST AIR TRANSPORT RATIO OF LESS THAN 0.5% AS TESTED TO AHRI 1060. THE CASING LEAKAGE RATE SHALL NOT EXCEED 0.50 CFM PER SQUARE FOOT OF CASING SURFACE AREA AT POSITIVE PRESSURE +5" WC AND -6" WC AT NEGATIVE PRESSURE SECTIONS.
- 5. PROVIDE ALL OUTSIDE AIR INTAKES AND EXHAUST AIR OPENINGS WITH LOW LEAKAGE DAMPERS. LOW LEAKAGE DMAPERS SHALL HAVE A MINIMUM LEAKAGE RATE OF 3 CFM/SQUARE FOOT WITH A DIFFERENTIAL PRESSURE OF ONE INCH GAUGE AGAINST THE DAMPER.
- 6. PROVIDE WITH FREE STANDING SPRING ISOLATOR THAT ARE LATERALLY STABLE WITHOUT HOUSING AND COMPLETE WITH A MOLDED NEOPRENE ACOUSTICAL FRICTION PAD BETWEEN THE BASEPLATE AND THE SUPPORT. SPRING ISOLATOR SHALL BE CAPABLE OF MINIMUM 0.75" DEFLECTION.

												AIR HAI	NDLIN	IG U	NIT :	SCHE	DULE											
	SUPPLY FAN DATA								CHILLED WATER COOLING COIL DATA								HOT WATER HEATING COIL DATA											
	S.A. ELECTRICAL DATA				TOTAL								MAX.															
		C.F.M.	O.A.	E.S.P.		FAN					CAPACITY	CAPACITY	E.D.B.	E.W.B.	E.W.T.	L.W.T.		A.P.D.	W.P.D.	CAPACITY	E.D.B.	L.D.B.	E.W.T.		L.W.T.	A.P.D.	W.P.D.	
TAG	TYPE	(MAX/MIN)	C.F.M.	(IN. WG.)	H.P.	TYPE	VOLTS	PHASE	M.C.A.	MOCP	M.B.H.	M.B.H.	(°F)	(°F)	(°F)	(°F)	G.P.M.	(IN. WG.)	(FT. WG.)	M.B.H.	(°F)	(°F)	(°F)	G.P.M.	(°F)	(IN. WG.)	(FT. WG.)	REMARKS
HU-1	UPFLOW	1200 / 600	85	0.75	1	DIRECT	208	3	6	15	42.6	32.2	76.1	63.8	44	54	8.48	0.88	5.63	23.6	66.9	85.0	140	1.4	106	0.19	0.10	SEE NOTES
HU-2	UPFLOW	840 / 420	250	0.50	1	DIRECT	208	3	6	15	43.6	25.2	79.8	69.2	44	54	8.68	1.09	11.42	26.4	56.0	85.0	140	1.5	106	0.20	0.23	SEE NOTES
HU-3	UPFLOW	840 / 420	250	0.50	1	DIRECT	208	3	6	15	43.6	25.2	79.8	69.2	44	54	8.68	1.09	11.42	26.4	56.0	85.0	140	1.5	106	0.20	0.23	SEE NOTES

- 1. PROVIDE EQUIPMENT WITH 22 GAUGE GALVANIZED STEEL EXTERIOR CASING WITH 1" THICK CLOSED CELL FOAM INSULATION (NON VOC) FOR ENTIRE UNIT, 18 GAUGE STAINLESS STEEL DRAIN PAN, AND 2" MERV 8 FILTER.
- 2. LEAVING AIR TEMPERATURE IS TO BE PROVIDED AT THE UNIT DISCHARGE, TOTAL & SENSIBLE CAPACITIES ARE "NET" VALUES TO BE PROVIDED DOWNSTREAM OF THE SUPPLY AIR FAN.
- 3. PROVIDE WITH DIRECT DRIVE PLENUM FANS WITH VARIABLE SPEED EC MOTORS.
- 5 PROVIDE WITH RACNET MS/TP INTERFACE
- 4. PROVIDE WITH THE FOLLOWING SECTIONS: ANGLED FILTER, COOLING COIL, REHEAT COIL, AND FAN.

5.	PROVIDE WITH	BACNET	MS/TP II	NIERFACE
^	DDOM (DE MITH			000111011

6. PROVIDE WITH FREE STANDING SPRING ISOLATOR THAT ARE LATERALLY STABLE WITHOUT HOUSING AND COMPLETE WITH A MOLDED NEOPRENE ACOUSTICAL FRICTION PAD BETWEEN THE BASEPLATE AND THE SUPPORT. SPRING ISOLATOR SHALL BE CAPABLE OF MINIMUM 0.75" DEFLECTION.

		GRIL	LE, REG	ISTER	& DIFF	FUSER SCHEDULE
			C.F.M.	NECK	MAX.	
TAG	TYPE	SERVICE	RANGE	SIZE	P.D.	REMARKS
Α	DIFFUSER	SUPPLY	40-125	8x6	0.1	DOUBLE DEFLECTION, 3/4" BLADE SPACING, FRONT BLADES IN SHORT DIMENSION.
В	DIFFUSER	SUPPLY	140-210	12x6	0.1	DOUBLE DEFLECTION, 3/4" BLADE SPACING, FRONT BLADES IN SHORT DIMENSION.
С	DIFFUSER	SUPPLY	40-55	6"Ø	0.1	LAY-IN, 24x24 PANEL, 4-WAY BLOW PATTERN, ADJUSTABLE DISCHARGE, LOUVERED FACE
Х	GRILLE	RETURN	170-1,115	18x18	0.1	1/2"X1/2"X1/2" EGGCRATE CORE, 45° BLADE DEFLECTION, SIGHT PROOF.
Υ	GRILLE	EXHAUST	50	8x6	0.1	1/2"X1/2"X1/2" EGGCRATE CORE, 45° BLADE DEFLECTION, SIGHT PROOF.
Z	GRILLE	EXHAUST	20-100	6x6	0.1	1/2"X1/2"X1/2" EGGCRATE CORE, 45° BLADE DEFLECTION, SIGHT PROOF.

- THE FOLLOWING NOTES ARE TYPICAL UNLESS OTHERWISE NOTED:
- 1. PROVIDE ALUMINUM DIFFUSERS AND REGISTERS WITH OPPOSED BLADE VOLUME DAMPERS, BAKED STANDARD WHITE ENAMEL FINISH
- (INCLUDING HEAD OF SCREWS), MAXIMUM NC=25 AT HIGHEST CFM AND PROVIDE SQUARE TO ROUND TRANSITION AS REQUIRED. 2. PROVIDE 4-WAY PATTERN CEILING DIFFUSERS, U.O.N. ON PLANS OR SCHEDULE.
- 3. MAXIMUM PRESSURE DROP SHALL INCLUDE VOLUME DAMPER WHERE DAMPER IS PROVIDED.

			НОТ	WATE	HOI WAIER BUILER SCHEDULE														
		INPUT	OUTPUT		L.W.T.	E.W.T.		ELECTRICA	AL DATA										
TAG	FUEL	(M.B.H.)	(M.B.H.)	G.P.M.	(°F)	(°F)	M.C.A.	M.O.C.P.	VOLTS	PHASE	REMARKS								
B-1	NATURAL GAS	399.9	379	20	140	100	12	15	115	1	SEE NOTES								
B-2	NATURAL GAS	399.9	379	20	140	100	12	15	115	1	SEE NOTES								
B-3	NATURAL GAS	399.9	379	20	140	100	12	15	115	1	SEE NOTES								

- 1. PROVIDE SUITABLE FOR 14 IN. W.C GAS PRESSURE.
- 2. PROVIDE SUITABLE FOR 160 PSI WORKING PRESSURE.
- 3. PROVIDE ALL TRIM AND APPURTENANCES RECOMMENDED FOR INDICATED APPLICATION.
- 4. PROVIDE CONDENSING BOILER WITH MANUFACTURER'S CONTROLLER AND BACNET MS/TP INTERFACE 5. PROVIDE MANUFACTURER'S SINGLE NEUTRALIZATION KIT SIZED FOR ALL BOILERS. SIZE PER MANUFACTURER'S RECOMMENDATION.
- 6. PROVIDE BOILERS WITH CSD-1 CONTROLS.
- 7. PROVIDE BOILER WITH VARIABLE SPEED PRIMARY PUMP, CONTROLLABLE BY THE BOILER AND RATED FOR MAX FLOW AND 25 FEET OF HEAD.

	G	AS FIRED	UNIT	HEATER	SCHEDULE	
INPUT CAPACITY	M.B.H. OUTPUT	APPROX.	MOTOR	ELEC	TRICAL DATA	
(C.F.H.)	CAPACITY	C.F.M.	H.P.	VOLTS	PHASE	REMARKS
30	24.6	505	1/15	115	1	SEE NOTES
	(C.F.H.)	INPUT CAPACITY M.B.H. OUTPUT (C.F.H.) CAPACITY	INPUT CAPACITY M.B.H. OUTPUT APPROX. (C.F.H.) CAPACITY C.F.M.	INPUT CAPACITY M.B.H. OUTPUT APPROX. MOTOR (C.F.H.) CAPACITY C.F.M. H.P.	INPUT CAPACITY M.B.H. OUTPUT APPROX. MOTOR ELEC (C.F.H.) CAPACITY C.F.M. H.P. VOLTS	INPUT CAPACITY M.B.H. OUTPUT APPROX. MOTOR ELECTRICAL DATA (C.F.H.) CAPACITY C.F.M. H.P. VOLTS PHASE

- 1. PROVIDE WITH REMOTE WALL MOUNTED THERMOSTAT, INTEGRAL ELECTRICAL DISCONNECT AND PROPELLER.
- 2. PROVIDE SEPARATED COMBUSTION UNIT HEATER WITH 30° DEFLECTOR HOOD, INTERNAL OVERLOAD PROTECTION, CONTROL TRANSFORMER, MULTI-TRY IGNITION WITH 100% LOCKOUT, FAN RELAY, SINGLE-STAGE NATURAL GAS VALVE, INTEGRAL DISCONNECT, FAN GUARD, SIDE ACCESS FOR BURNERS AND CONTROLS, ALUMINIZED STEEL HEAT EXCHANGER, MANUFACTURER'S HORIZONTAL CONCENTRIC VENT KIT, AND MANUFACTURER'S SUSPENSION KIT.

						AIR	COOLE	CHILI	LER SO	CHEDUI	LE					
	CAPACITY	EVAPORATOR						CONDENS	SER FAN	COMPR	RESSOR	ELECTRICAL DATA				
TAG	(TONS)	G.P.M.	P.D. (FT.)	E.W.T. (°F)	L.W.T. (°F)	EER	IPLV EER	QUANTITY	F.L.A.	TYPE	QUANTITY	M.C.A.	M.O.C.P.	VOLTS	PHASE	REMARKS
CH-1	80	168	12.9	54	44	9.19	13.87	6	6.2	SCROLL	4	354	400	208	3	SEE NOTES

- 1. COIL COATINGS SHALL MEET 6,000 HOUR SALT SPRAY TEST IN ACCORDANCE WITH ASTM B177-90.
- 2. PROVIDE WITH CONTROL VOLTAGE TRANSFORMER AND SEPARATE 120 VOLT CIRCUIT FOR EVAPORATOR HEAT TAPE. 3. PROVIDE MANUFACTURER'S DDC CONTROL PANEL, CONDENSER COIL GUARDS, SOUND ATTENUATION PACKAGE, AND WIDE AMBIENT CONDENSER.
- 4. PROVIDE WITH SINGLE POINT POWER CONNECTION AND INTEGRAL DISCONNECT.
- 5. PROVIDE WITH BACNET MS/TP INTERFACE, AND MANUFACTURER'S VIBRATION ISOLATION PADS.
- 6. CAPACITY BASED ON 96°F AMBIENT.
- 7. BRAZED PLATE HEAT EXCHANGER IS ACCEPTABLE IF A 10 YEAR PARTS AND LABOR WARRANTY IS PROVIDED.

				THROUGH	WALL	HEA	T PUMP S	CHEDU	LE			
							SUPPLEMENTAL					
	FAN DATA		COOLING DATA			G DATA	ELECTRIC HEATER					
	HIGH/LOW	TOTAL		DEHUMIDIFICATION	TOTAL		SIZE					
TAG	AIR C.F.M.	M.B.H.	EER	(PINTS / HR.)	M.B.H.	C.O.P.	KW	M.C.A.	M.O.C.P.	VOLTS	PHASE	REMARKS
TWHP-1	400	12.0	12.0	2.8	12.0	3.6	2.45	17.2	20	208	1	SEE NOTES
NOTES:												

- 1. PROVIDE WITH WALL MOUNTED PROGRAMMABLE THERMOSTAT/HUMIDISTAT AND INTERFACED WITH DDC CONTROL SYSTEM.
- 2. COOLING CAPACITY BASED ON E.A.T. = 75°F DB/60°F AMBIENT AIR TEMPERATURE.
- 3. HEATING CAPACITY BASED ON E.A.T. = 68°F DB AND 22°F AMBIENT AIR TEMPERATURE.
- 4. SUPPLEMENTAL ELECTRIC HEATER F.L.A. INCLUDED. ONE DISCONNECT SWITCH REQUIRED FOR EACH INDOOR UNIT. 5. PROVIDE MANUFACTURERS STANDARD SUB-BASE, DRAIN KIT, LEVELING LEGS, POWER CORD, EXTERIOR GRILLE, AND CORROSION PROTECTION.
- 6. PROVIDE WITH ANTI-LIGATURE COVERS EQUIPPED WITH 1/2" INSULATION, FRONT ACCESS PANEL, AND INSULATED SUPPLY CONNECTION FROM TWHP TO ANTI-LIGATURE COVER.
- REFER TO ARCHITECTURAL DOCUMENTS FOR ADDITIONAL ANTI-LIGATURE COVER REQUIREMENTS.


				НОТ	WAT	ER UN	IIT HE	ATER	SCHE	DULE		
			AIR TEMP	PERATURE					El	LECTRICAL DA	ГА	
TAG	C.F.M.	M.B.H.	E.A.T	L.A.T.	E.W.T.	L.W.T.	P.D. FT.	GPM	HP	VOLTS	PHASE	REMARKS
UH-1	730	17.3	60.0	82.0	140	128	0.3	3.0	1/12	115	1	SEE NOTES
UH-2	730	17.3	60.0	82.0	140	128	0.3	3.0	1/12	115	1	SEE NOTES
UH-3	730	17.3	60.0	82.0	140	128	0.3	3.0	1/12	115	1	SEE NOTES

1. PROVIDE WITH WALL MOUNTED BACNET MS/TP THERMOSTAT.

MARINE CORPS BASE

## DISCLOSURE OF INFORMATION

- CONTRACTOR SHALL COMPLY AS FOLLOWS: (A) THE CONTRACTOR SHALL NOT RELEASE TO ANYONE OUTSIDE THE CONTRACTOR'S ORGANIZATION ANY UNCLASSIFIED INFORMATION,
- REGARDLESS OF MEDIUM (E.G., FILM, TAPE, DOCUMENT), PERTAINING TO ANY PART OF THIS CONTRACT OR ANY PROGRAM RELATED TO THIS CONTRACT.
- (1) THE CONTRACTING OFFICER HAS GIVEN PRIOR WRITTEN APPROVAL; OR (2) THE INFORMATION IS OTHERWISE IN THE PUBLIC DOMAIN BEFORE THE DATE OF RELEASE
- RELEASED, THE MEDIUM TO BE USED, AND THE PURPOSE FOR THE RELEASE. THE CONTRACTOR SHALL SUBMIT ITS REQUEST TO THE CONTRACTING OFFICER AT LEAST 45 DAYS BEFORE THE PROPOSED DATE FOR RELEASE. THE CONTRACTOR AGREES TO INCLUDE A SIMILAR REQUIREMENT IN EACH SUBCONTRACT UNDER HIS CONTRACT. SUBCONTRACTORS SHALL SUBMIT REQUESTS FOR AUTHORIZATION TO RELEASE THROUGH THE PRIME CONTRACTOR TO THE CONTRACTING OFFICER.

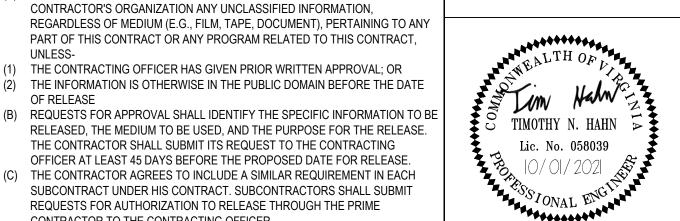

The Walker Group Architecture, Inc
PO Box 541, New Bern, NC 28563
252.636.8778 (PHONE)

WALKER

#GROUP 252.636.8992 (FAX) DES. T. HAHN DR. C. LAMBERT CHK. J. KULENGUSKI SUBMITTED BY: B. WALKER DESIGN DIR. T.H. BURTON P.E. APPROVED: PWO OR OICC

CAMP LEJEUNE, NORTH CAROLINA REPAIR BEQ FC530 MECHANICAL SCHEDULES

SCALE: NOTED | SPEC. 20-0075

DATE | SIZE | CODE IDENT. NO NAVFAC DRAWING NO. 60035818 CONST. CONTR. NO. N40085-20-B-0075 DATE \_

SHEET **93** OF **141** 

SATISFACTORY TO: